

GENERAL NOTES:

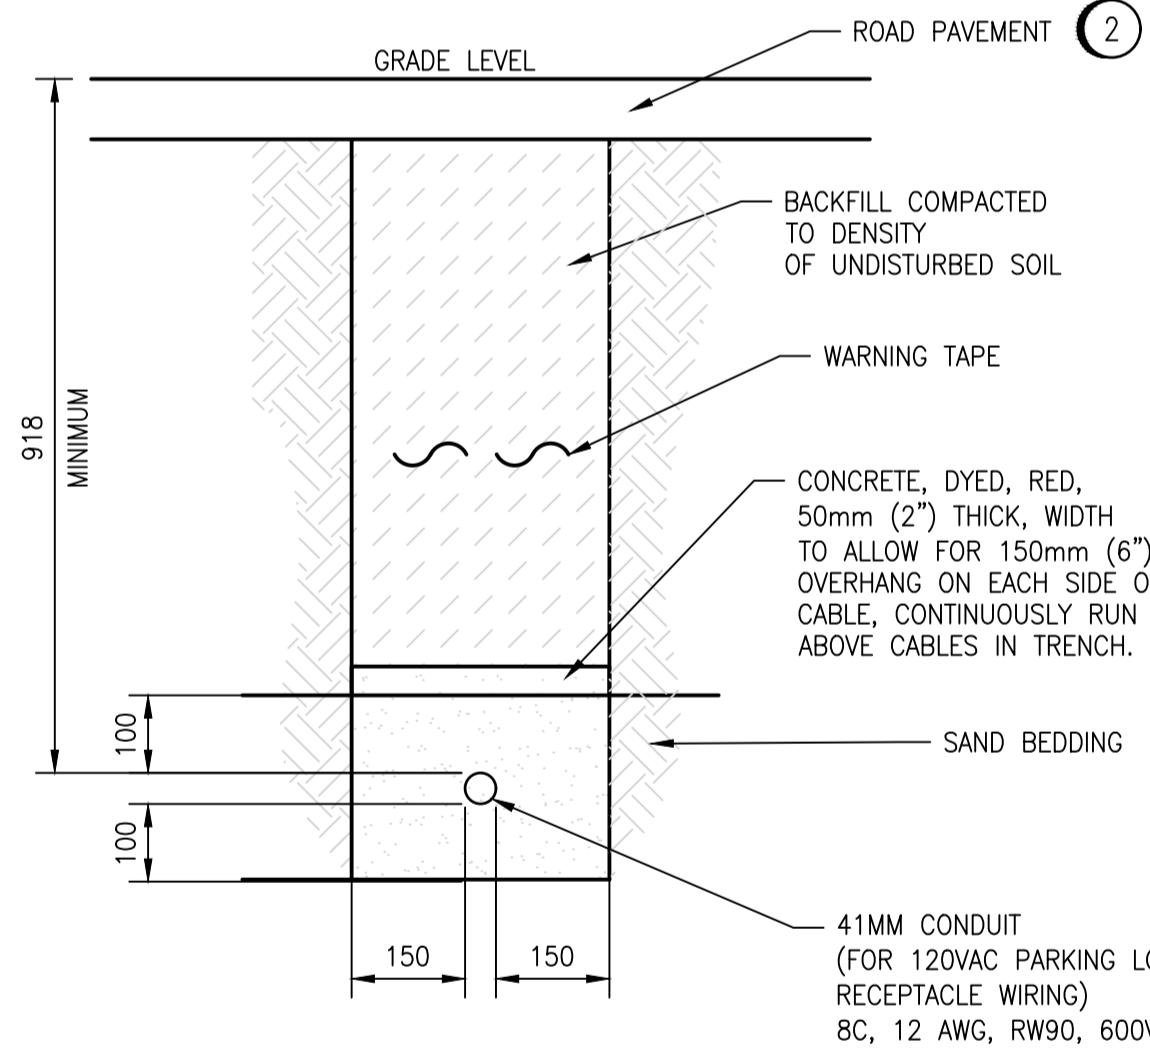
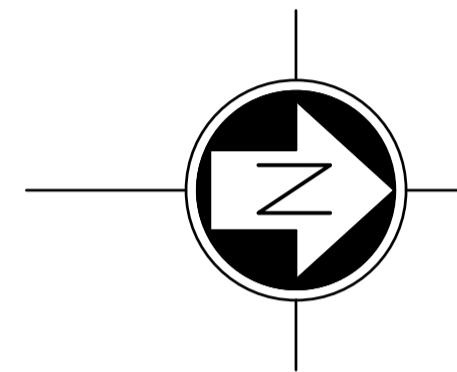
1. ALL CONDUIT AND CABLING IS NEW AND TO BE PROVIDED BY THE CONTRACTOR.
2. ALL EQUIPMENT SHOWN ON THIS DRAWING IS NEW UNLESS OTHERWISE INDICATED AS EXISTING.

CONSTRUCTION NOTES:

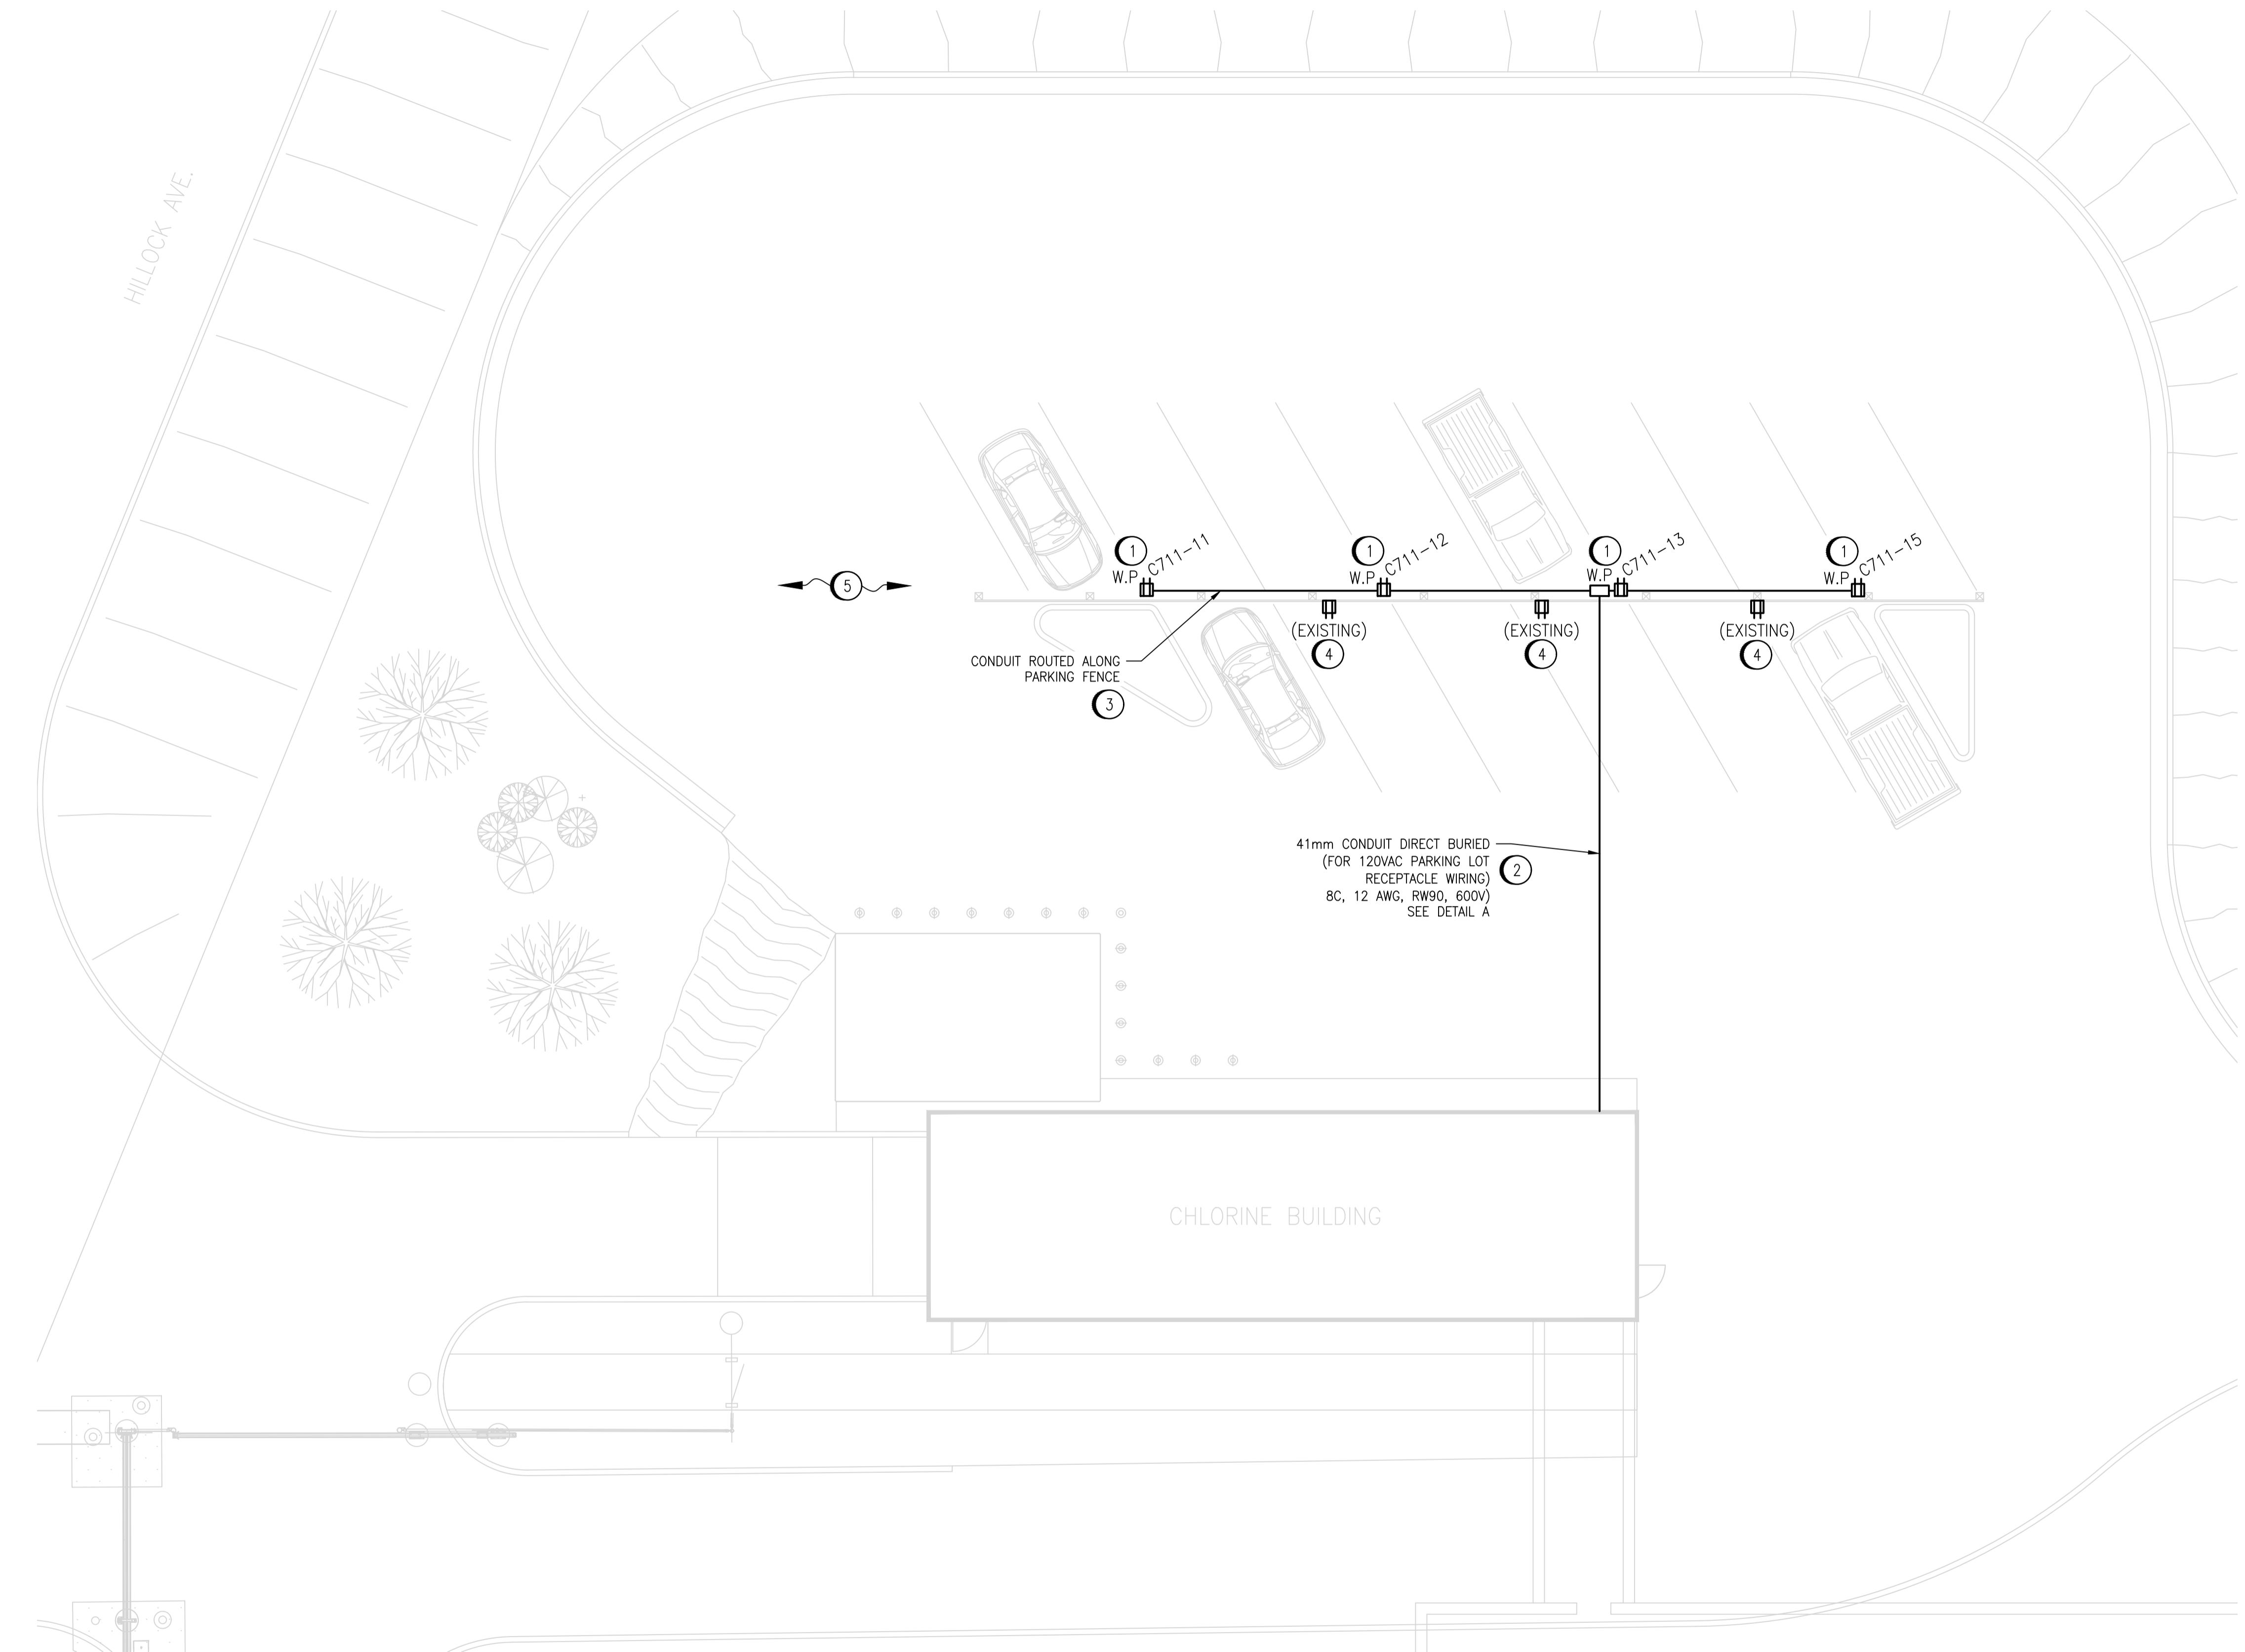
- 1 PROVIDE NEW PARKING LOT RECEPTACLE. RECEPTACLE TO BE IPLC DUPLEX TYPE AND CONTAIN WEATHERPROOF IN USE COVERPLATE. NEW DUPLEX RECEPTACLE TO BE MOUNTED ON THE EXISTING PARKING LOT FENCE IN SIMILAR FASHION TO EXISTING RECEPTACLE ON OTHER SIDE OF FENCE. CONTRACTOR TO RUN CABLE IN CONDUIT FROM PNL-C711 IN CHLORINE ELECTRICAL AREA IN BASEMENT TO PARKING FENCE UNDERGROUND. REFER TO TRENCH DETAIL A.
- 2 CONTRACTOR TO CUT, PATCH, AND REPAIR CONCRETE AND ASPHALT TO ROUTE THE PARKING LOT WIRING. CONCRETE THICKNESS SHALL MATCH EXISTING.
- 3 PARKING LOT RECEPTACLE CABLING TO BE MOUNTED ALONG THE EXISTING FENCE WALL TO EACH RECEPTACLE IN PVC CONDUIT.
- 4 EXISTING RECEPTACLES FOR PARKING STALLS THAT ARE TO REMAIN. MODIFY WIRING ACCORDING. CONTRACTOR TO CONFIRM PANELBOARD CIRCUIT OF RECEPTACLE AND PROVIDE MARKUPS ON AS-BUILTS..
- 5 RECEPTACLES ASSOCIATED WITH PORTION OF EXISTING FENCE TO BE DEMOLISHED ARE TO BE REMOVED. ALL RECEPTACLE CIRCUITS ARE TO BE TRACED AND REMOVED BACK TO PANELBOARD. UPDATE PANEL SCHEDULE AS REQUIRED. REFER TO DRAWING 1-0640C-0006 FOR PANELBOARD SCHEDULE.

LEGEND:

W.P. = WEATHERPROOF

DETAIL A - TRENCH DETAIL

SCALE: NTS

CHLORINE BUILDING GROUND FLOOR

SCALE: 1 : 100

1-0640C-E0005	ELECTRICAL PANEL LAYOUT, MCC-C710/MCC-C720E
DRAWING NUMBER	REFERENCE DRAWINGS



						ENGINEER'S SEAL	THE CITY OF WINNIPEG Winnipeg	
DESIGNED BY:	V. ELIMBAN	CHECKED BY:	V. ELIMBAN	DRAWN BY:	V. ELIMBAN	APPROVED BY:	V. ELIMBAN	
SCALE:	1:100	ISSUED FOR CONSTRUCTION	BY: M. SKINNER	DATE:	2024/03/13	CONSULTANT NO.:	DATE: 2025/04/30	
00	ISSUED FOR TENDER AND CONSTRUCTION	2025/04/30	VE	VE				
NO.	REVISIONS	DATE	DESIGN	CHECK				

MCPHILLIPS PUMPING STATION  
CHLORINE SYSTEM UPGRADES  
PARKING LOT UPGRADES  
CHLORINE BUILDING

CITY DRAWING NUMBER: 1-0640C-E0016 SHEET: 00 REV: 00 SIZE: A1